


## WEST ELEVATION SCALE 1: 300

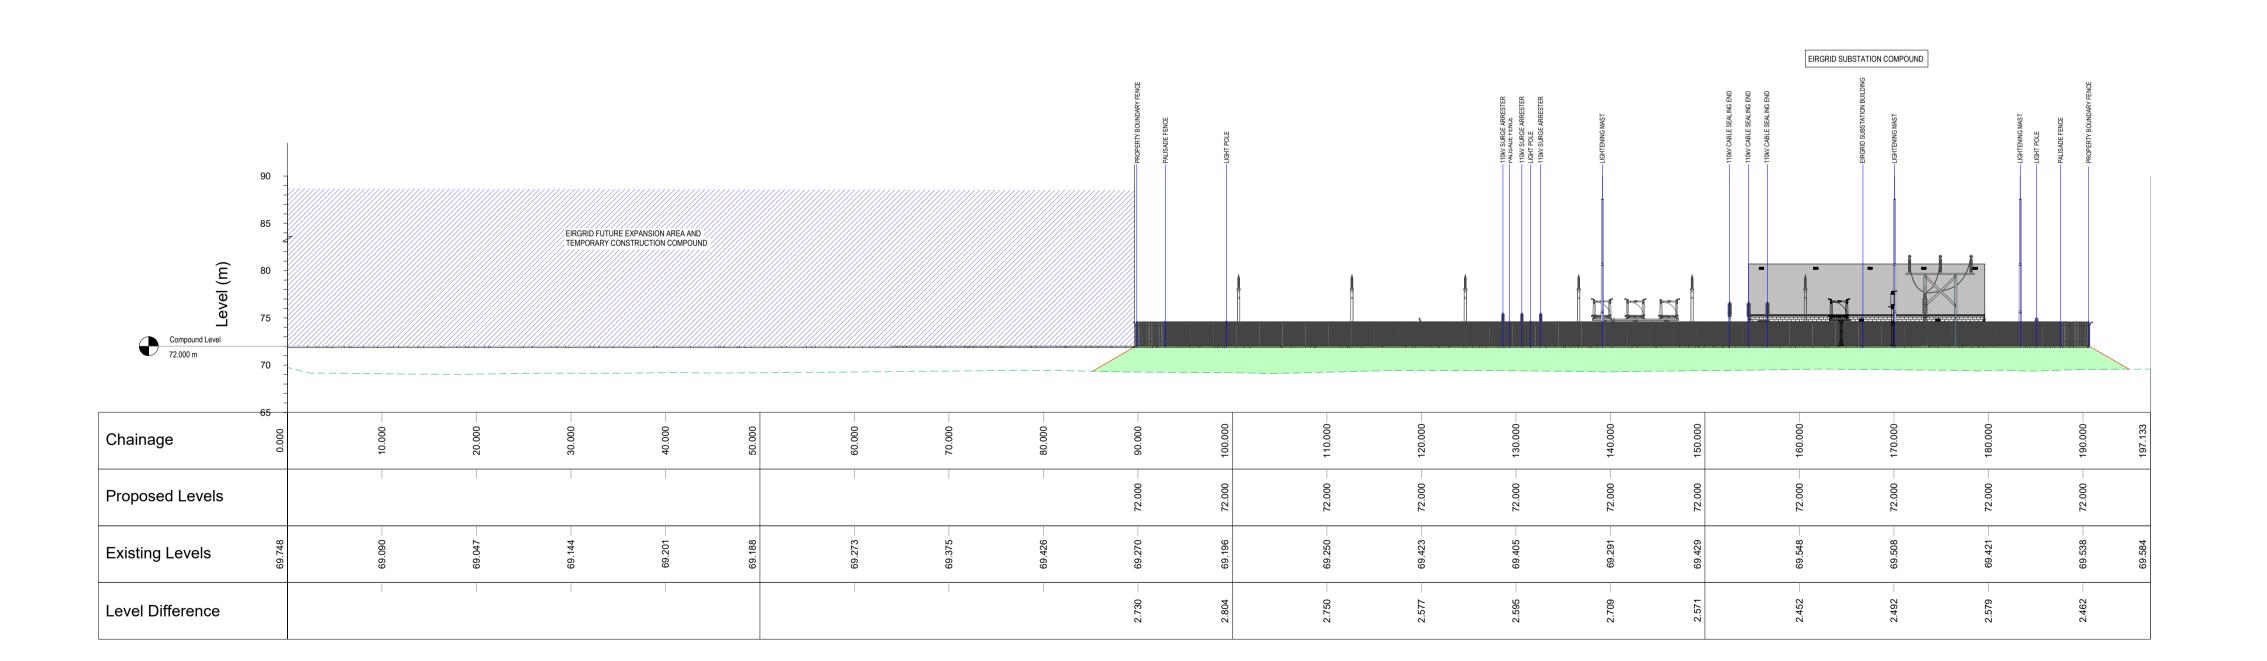

EAST ELEVATION SCALE 1: 400

DO NOT SCALE FROM THIS DRAWING. USE FIGURED DIMENSIONS IN

ALL CASES.
VERIFY DIMENSIONS ON SITE AND REPORT ANY DISCREPANCIES TO THE DESIGNERS IMMEDIATELY.

THIS DRAWING TO BE READ IN CONJUNCTION WITH THE DESIGNERS SPECIFICATION.

©THIS DRAWING IS COPYRIGHT AND MAY ONLY BE REPRODUCED WITH THE DESIGNERS PERMISSION.

- 1. ALL DRAWINGS ARE TO BE READ IN CONJUNCTION WITH ALL RELEVANT SPECIFICATIONS, BILLS OF QUANTITIES, ARCHITECTURAL, SERVICES AND ENGINEERING DRAWINGS.
- 2. ALL LEVELS ARE IN METRES RELATED TO ORDNANCE DATUM MALIN HEAD.
- 3. ANY DISCREPANCIES BETWEEN THESE DOCUMENTS SHALL BE BROUGHT TO THE ATTENTION OF THE ENGINEER.
- 4. DRAWINGS ARE NOT TO BE SCALED.
- 5. ALL DIMENSIONS ARE IN MILLIMETRES, UNLESS NOTED OTHERWISE.

LEGEND

—— EXISTING GROUND

PROPOSED COMPOUND LEVEL FILL EMBANKMENT

04	30/09/24	ISSUED FOR PLANNING	PJS	GMd		
03	04/06/24	ISSUED FOR PLANNING	PJS	GM		
02	29/04/24	ISSUED FOR PLANNING	PJS	GM		
01	22/11/23	ISSUED FOR PLANNING	PJS	GM		
ΕV	DATE	DESCRIPTION	BY	AP		
ROJECT:						

DERNACART WIND FARM 110kV SUBSTATION AND GRID CONNECTION

OVERALL COMPOUND ELEVATIONS 2

STATKRAFT IRELAND



		mwp.ie
DRAWN:	CHECKED:	APPROVED:
J.D.	G.McN.	P.C.
PROJECT NUMBER:	DATE:	SCALE @ A1:
23268	NOV`23	AS SHOWN
STATUS DESCRIPTION	1	STATUS:
FO	R APPROVAL	S4

23268 - MWP - 00 - ZZ - DR - C - 5205