


DO NOT SCALE FROM THIS DRAWING. USE FIGURED DIMENSIONS IN ALL CASES. VERIFY DIMENSIONS ON SITE AND REPORT ANY DISCREPANCIES TO THE DESIGNERS IMMEDIATELY. THIS DRAWING IS TO BE READ IN CONJUNCTION WITH THE DESIGNERS SPECIFICATION. ©THIS DRAWING IS COPYRIGHT AND MAY ONLY BE REPRODUCED WITH THE DESIGNERS PERMISSION.


- NOTE:**
1. ALL DRAWINGS ARE TO BE READ IN CONJUNCTION WITH ALL RELEVANT SPECIFICATIONS, BILLS OF QUANTITIES, ARCHITECTURAL, SERVICES AND ENGINEERING DRAWINGS.
 2. ALL LEVELS ARE IN METRES RELATED TO ORDNANCE DATUM MALIN HEAD.
 3. ANY DISCREPANCIES BETWEEN THESE DOCUMENTS SHALL BE BROUGHT TO THE ATTENTION OF THE ENGINEER.
 4. DRAWINGS ARE NOT TO BE SCALED.
 5. ALL DIMENSIONS ARE IN MILLIMETRES, UNLESS NOTED OTHERWISE.

LEGEND

	EXISTING GROUND
	PROPOSED COMPOUND LEVEL
	FILL EMBANKMENT

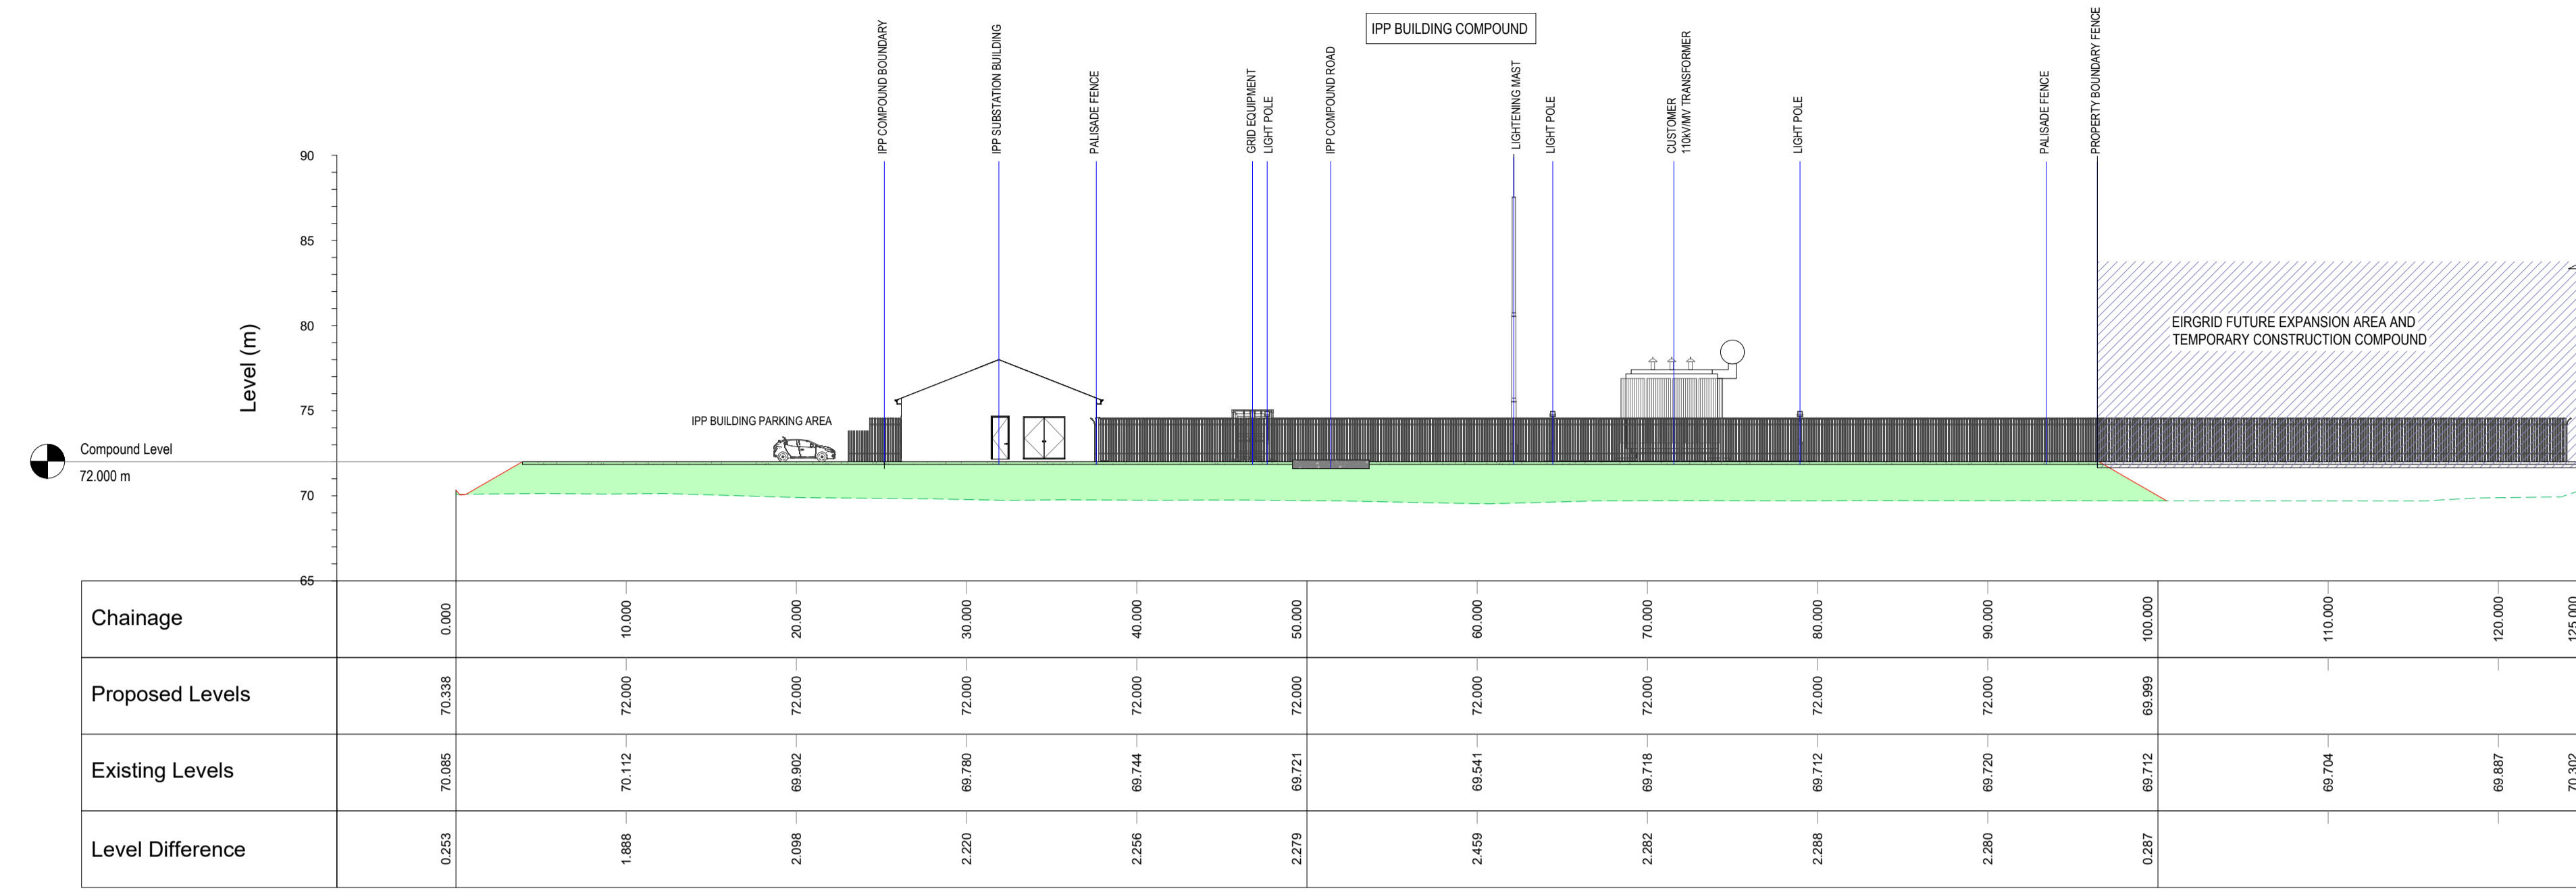

WEST ELEVATION
SCALE 1:300

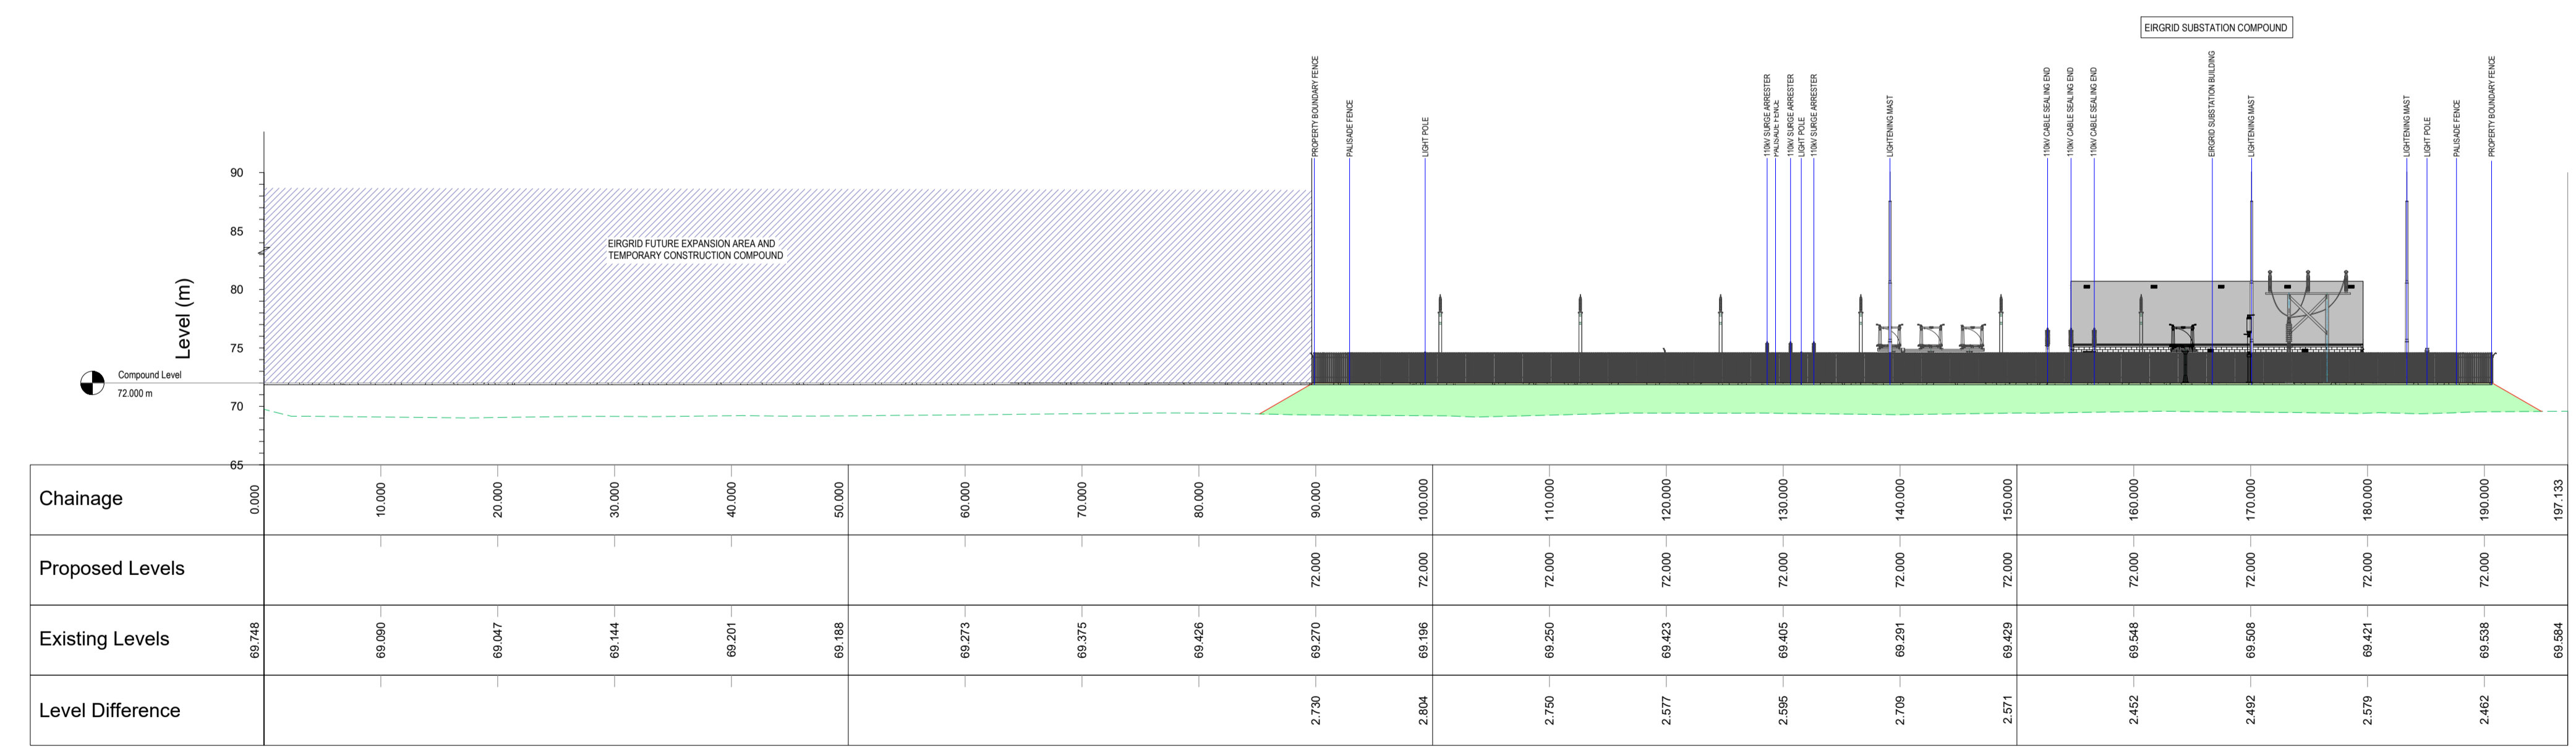

EAST ELEVATION
SCALE 1:400

REV	DATE	DESCRIPTION	BY	APP
P04	30/09/24	ISSUED FOR PLANNING	PJS	GMcN
P03	04/06/24	ISSUED FOR PLANNING	PJS	GMcN
P02	23/04/24	ISSUED FOR PLANNING	PJS	GMcN
P01	22/11/23	ISSUED FOR PLANNING	PJS	GMcN

PROJECT: DERNACART WIND FARM 110KV SUBSTATION AND GRID CONNECTION

TITLE: OVERALL COMPOUND ELEVATIONS 2

CLIENT: STATKRAFT IRELAND



DRAWN: J.D.	CHECKED: G. McN.	APPROVED: P.C.
PROJECT NUMBER: 23268	DATE: NOV '23	SCALE @ A1: AS SHOWN
STATUS DESCRIPTION: FOR APPROVAL		STATUS: S4

DRAWING NUMBER: 23268 - MWP - 00 - ZZ - DR - C - 5205	REV: P04
---	----------