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 - ALL LEVELS ARE IN METRES RELATED TO ORDNANCE DATUM MALIN HEAD.
 - ANY DISCREPANCIES BETWEEN THESE DOCUMENTS SHALL BE BROUGHT TO THE ATTENTION OF THE ENGINEER.
 - DRAWINGS ARE NOT TO BE SCALED.
 - ALL DIMENSIONS ARE IN MILLIMETRES, UNLESS NOTED OTHERWISE.

LEGEND

	EXISTING GROUND
	PROPOSED COMPOUND LEVEL
	FILL EMBANKMENT

P04	30/09/24	ISSUED FOR PLANNING	PJS	GMcN
P03	04/06/24	ISSUED FOR PLANNING	PJS	GMcN
P02	23/04/24	ISSUED FOR PLANNING	PJS	GMcN
P01	22/11/23	ISSUED FOR PLANNING	PJS	GMcN
REV	DATE	DESCRIPTION	BY	APP

PROJECT: DERNACART WIND FARM 110KV SUBSTATION AND GRID CONNECTION

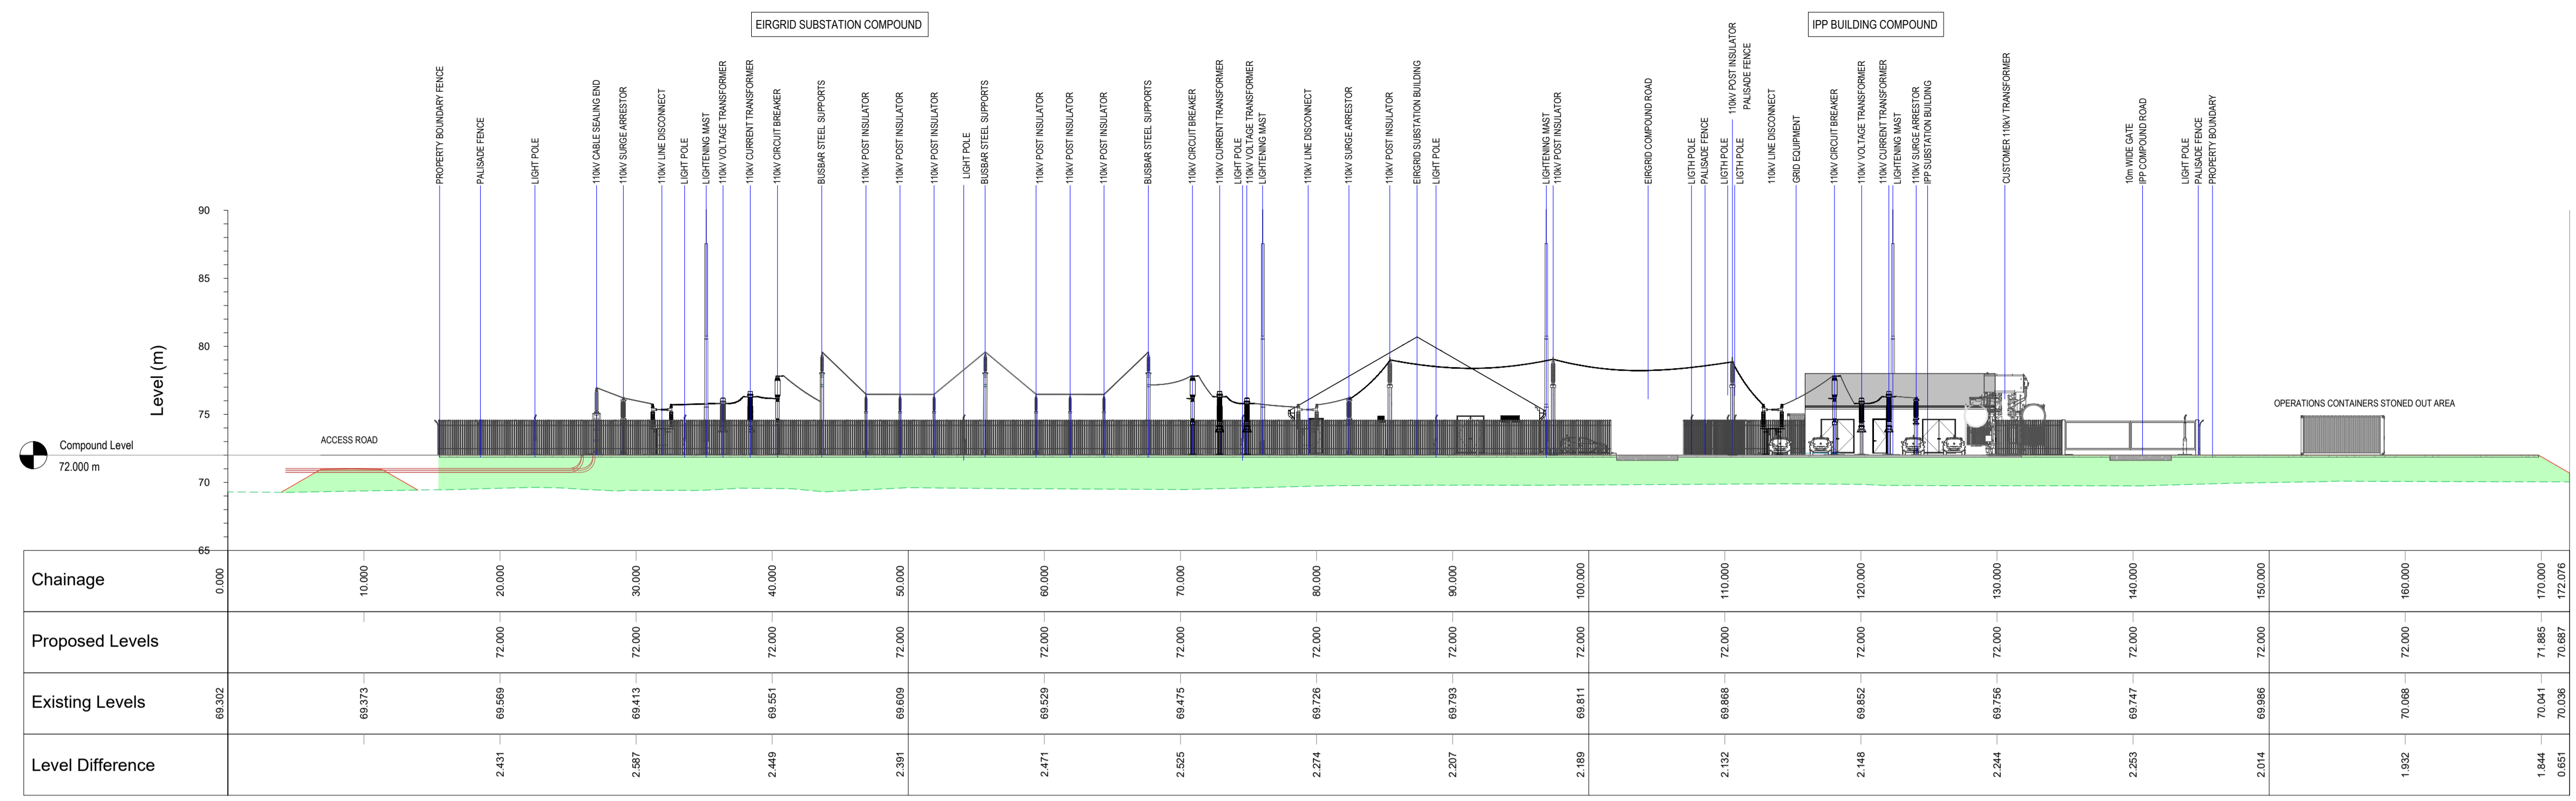
TITLE: OVERALL COMPOUND ELEVATIONS 1

CLIENT: STATKRAFT IRELAND

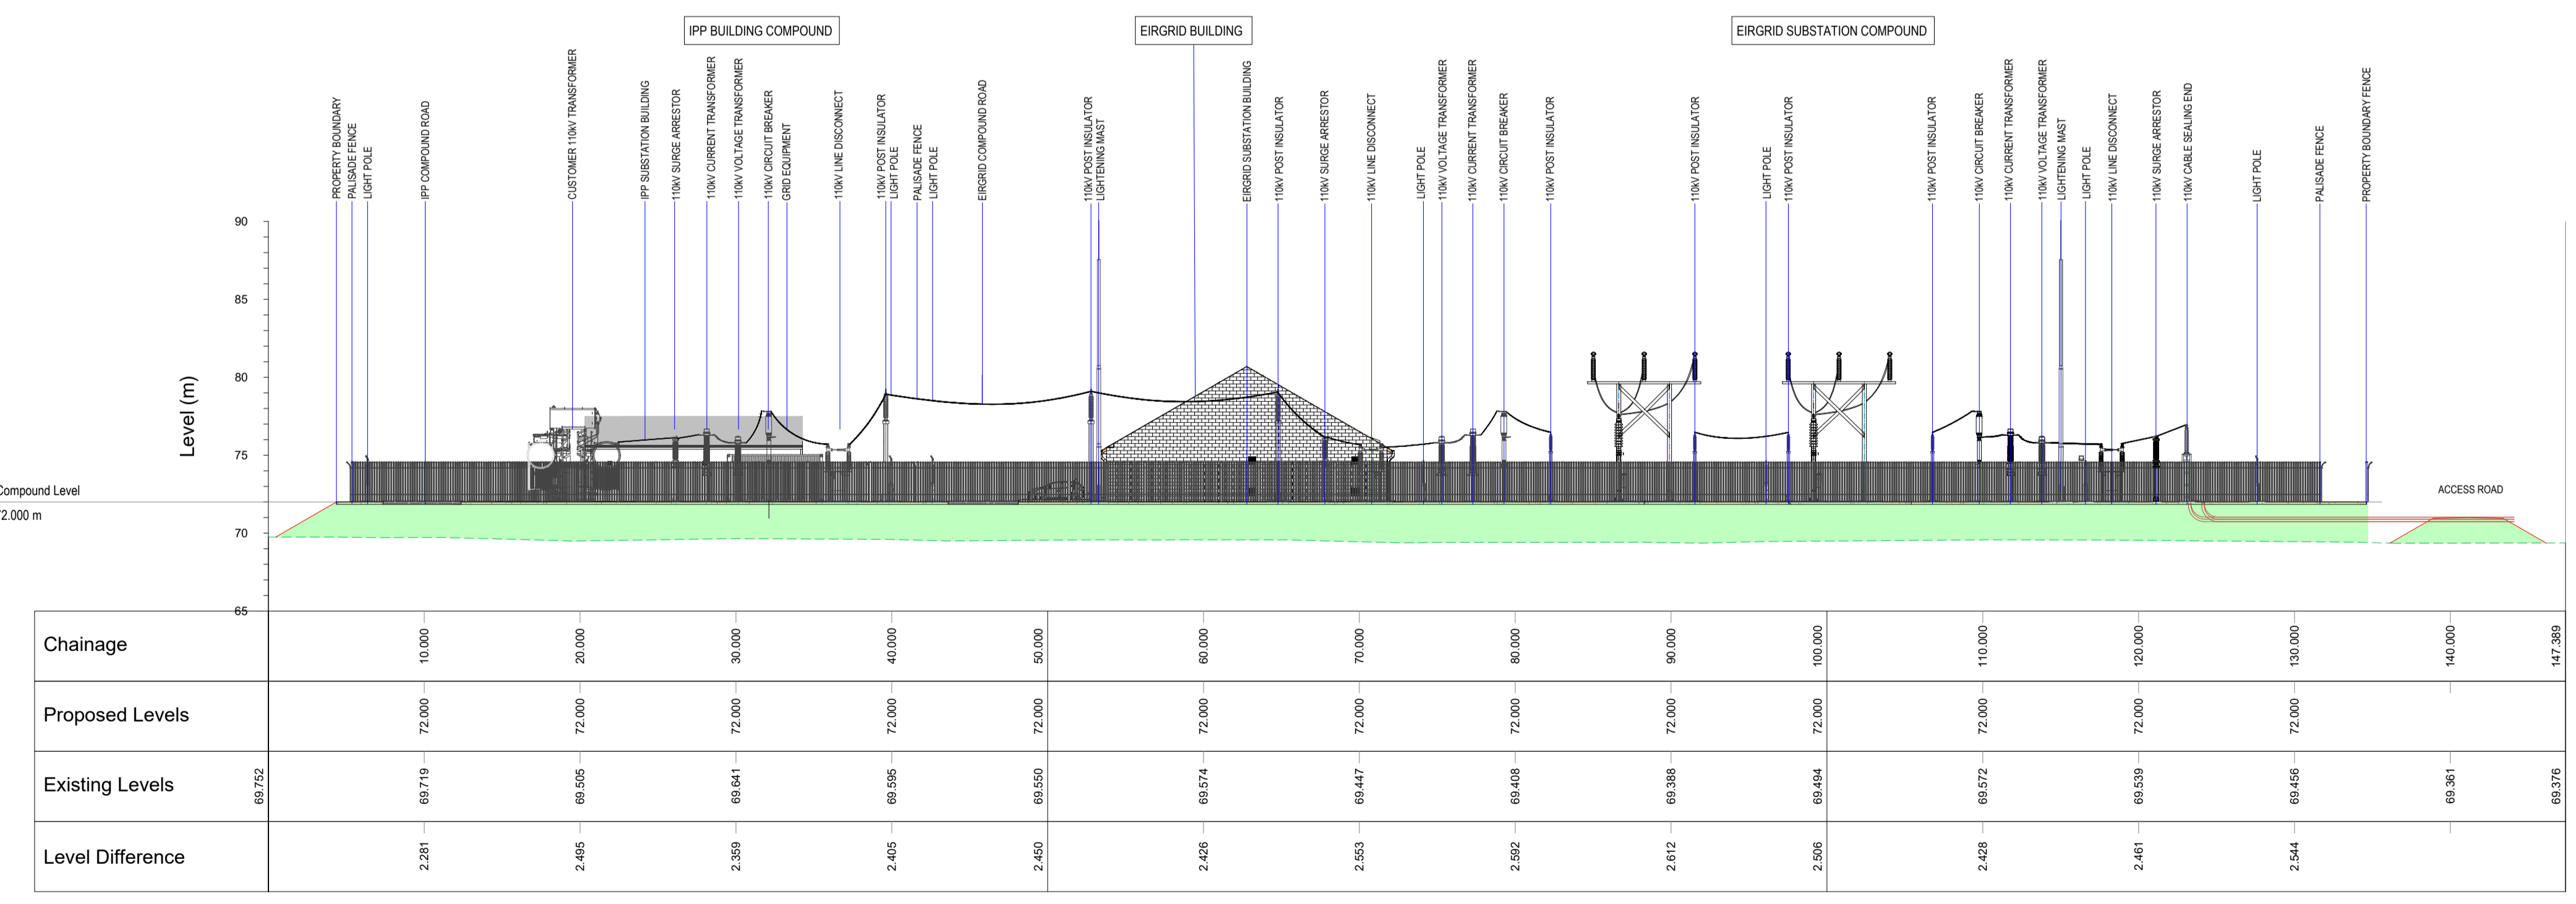


DRAWN: J.D.	CHECKED: G. McN.	APPROVED: P.C.
PROJECT NUMBER: 23268	DATE: NOV '23	SCALE @ A1: AS SHOWN
STATUS DESCRIPTION: FOR APPROVAL		STATUS: S4

DRAWING NUMBER: 23268 - MWP - 00 - ZZ - DR - C - 5204	REV: P04
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NORTH ELEVATION
SCALE 1:300



SOUTH ELEVATION
SCALE 1:300